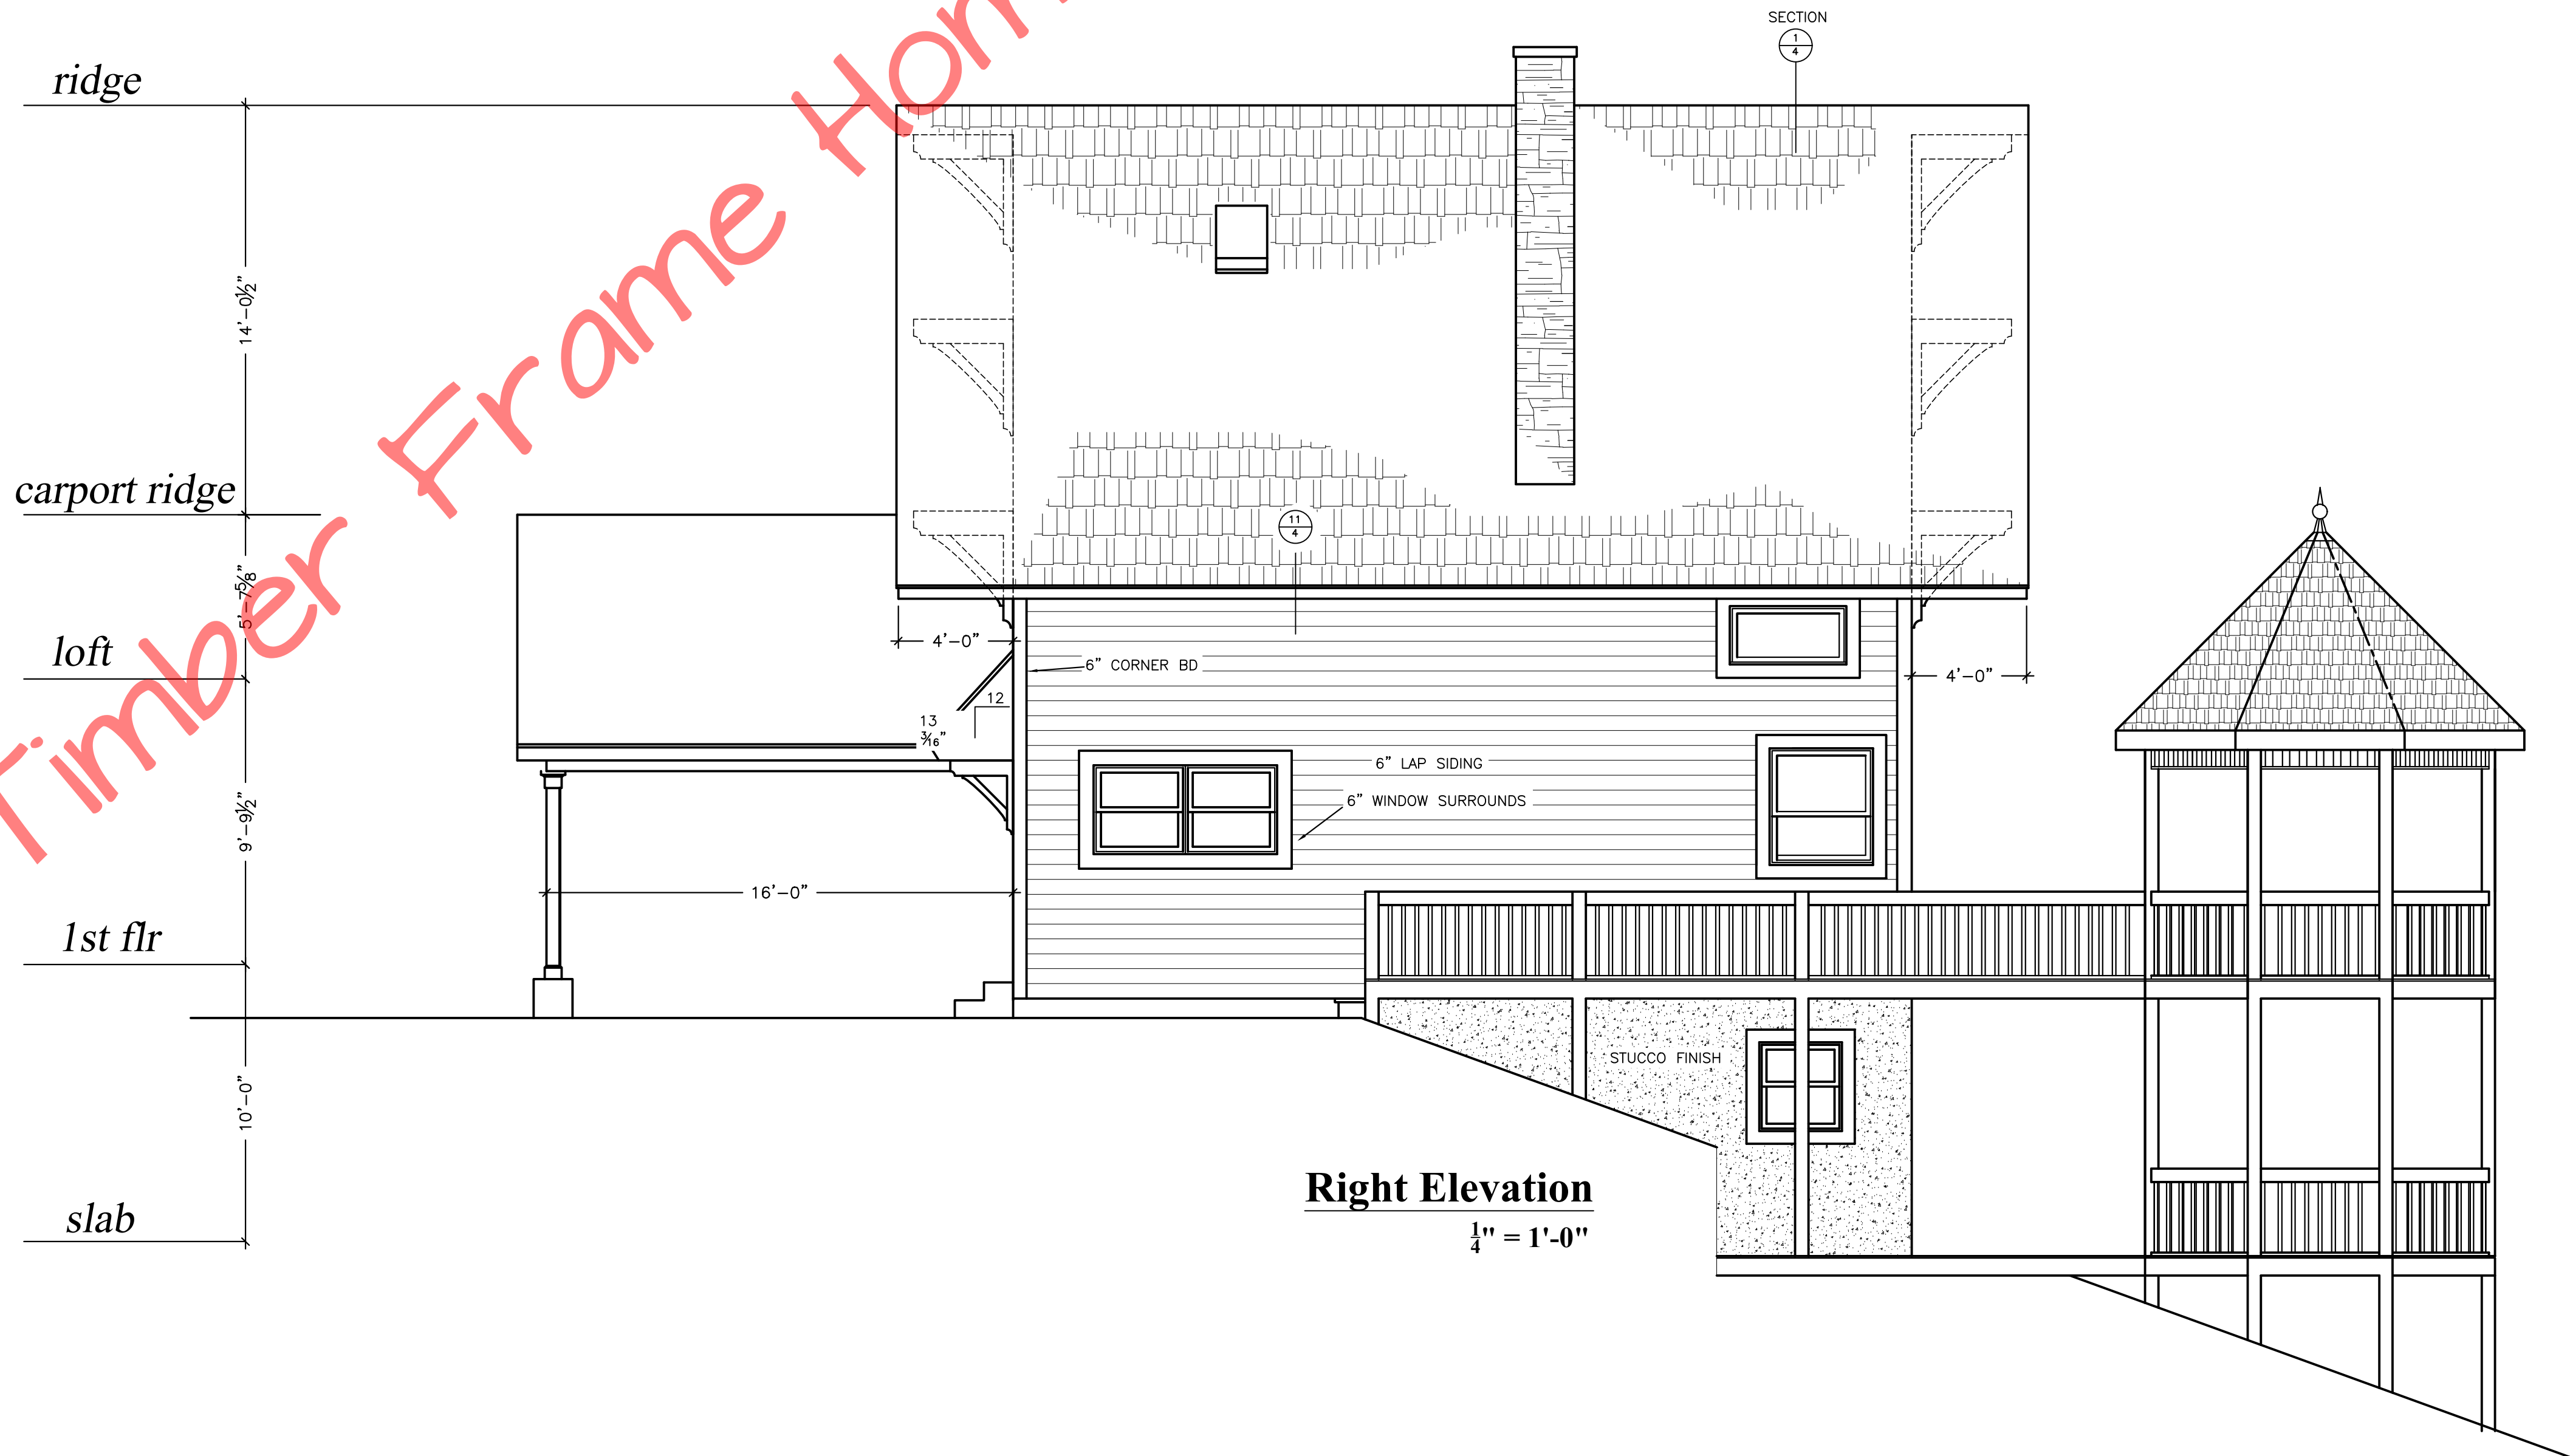




Front Elevation
 $\frac{1}{4}'' = 1'-0''$



Right Elevation
 $\frac{1}{4}'' = 1'-0''$

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Dover

SCALE: NOTED
 DATE: 04/21/2004

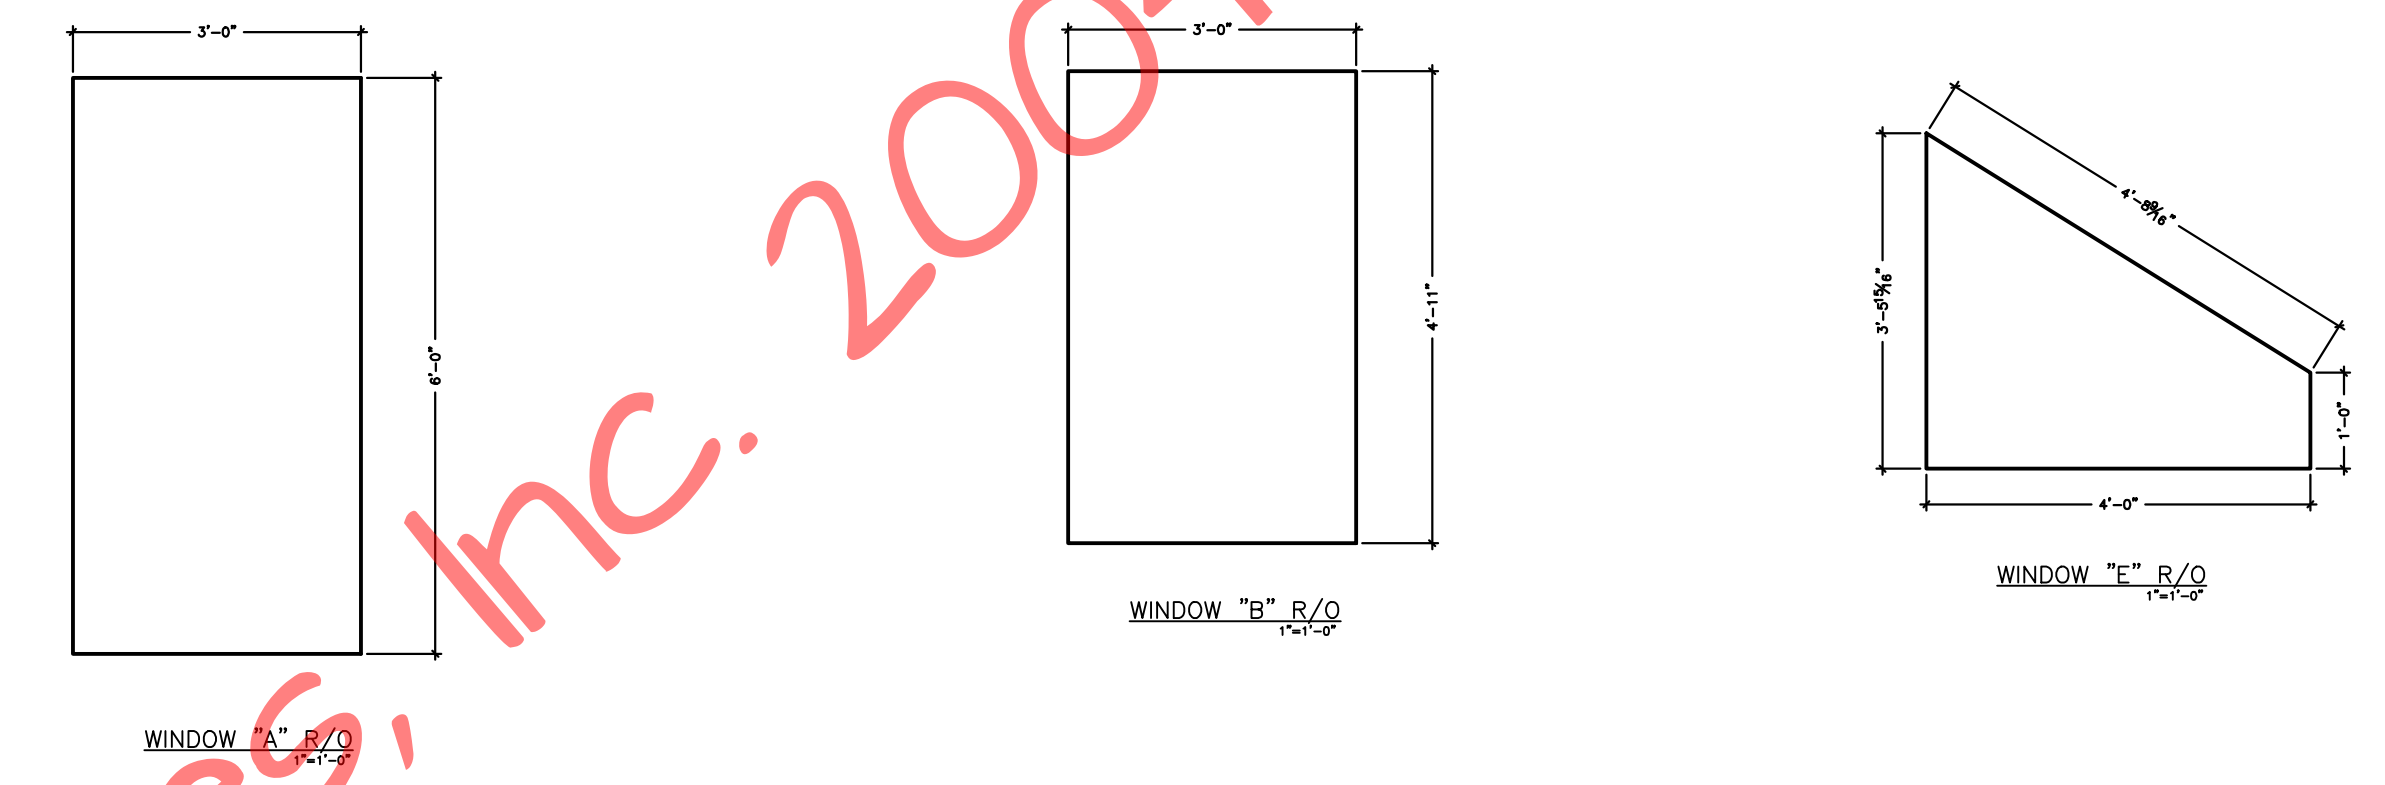
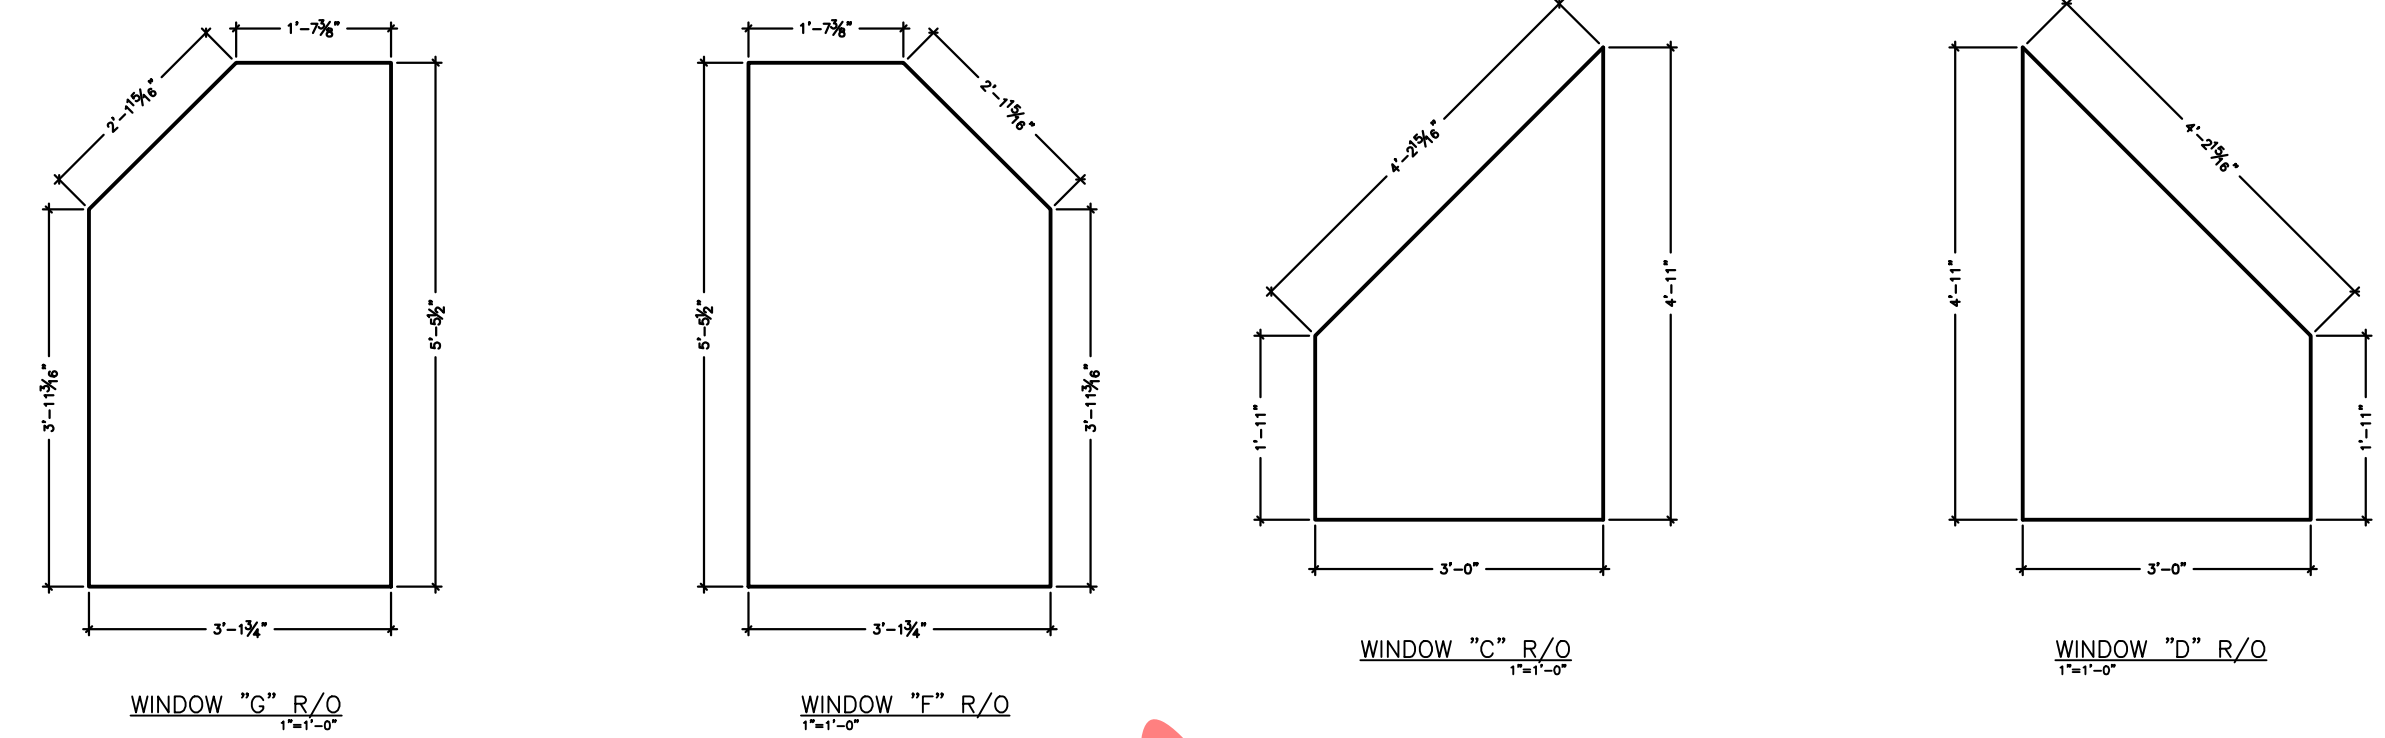
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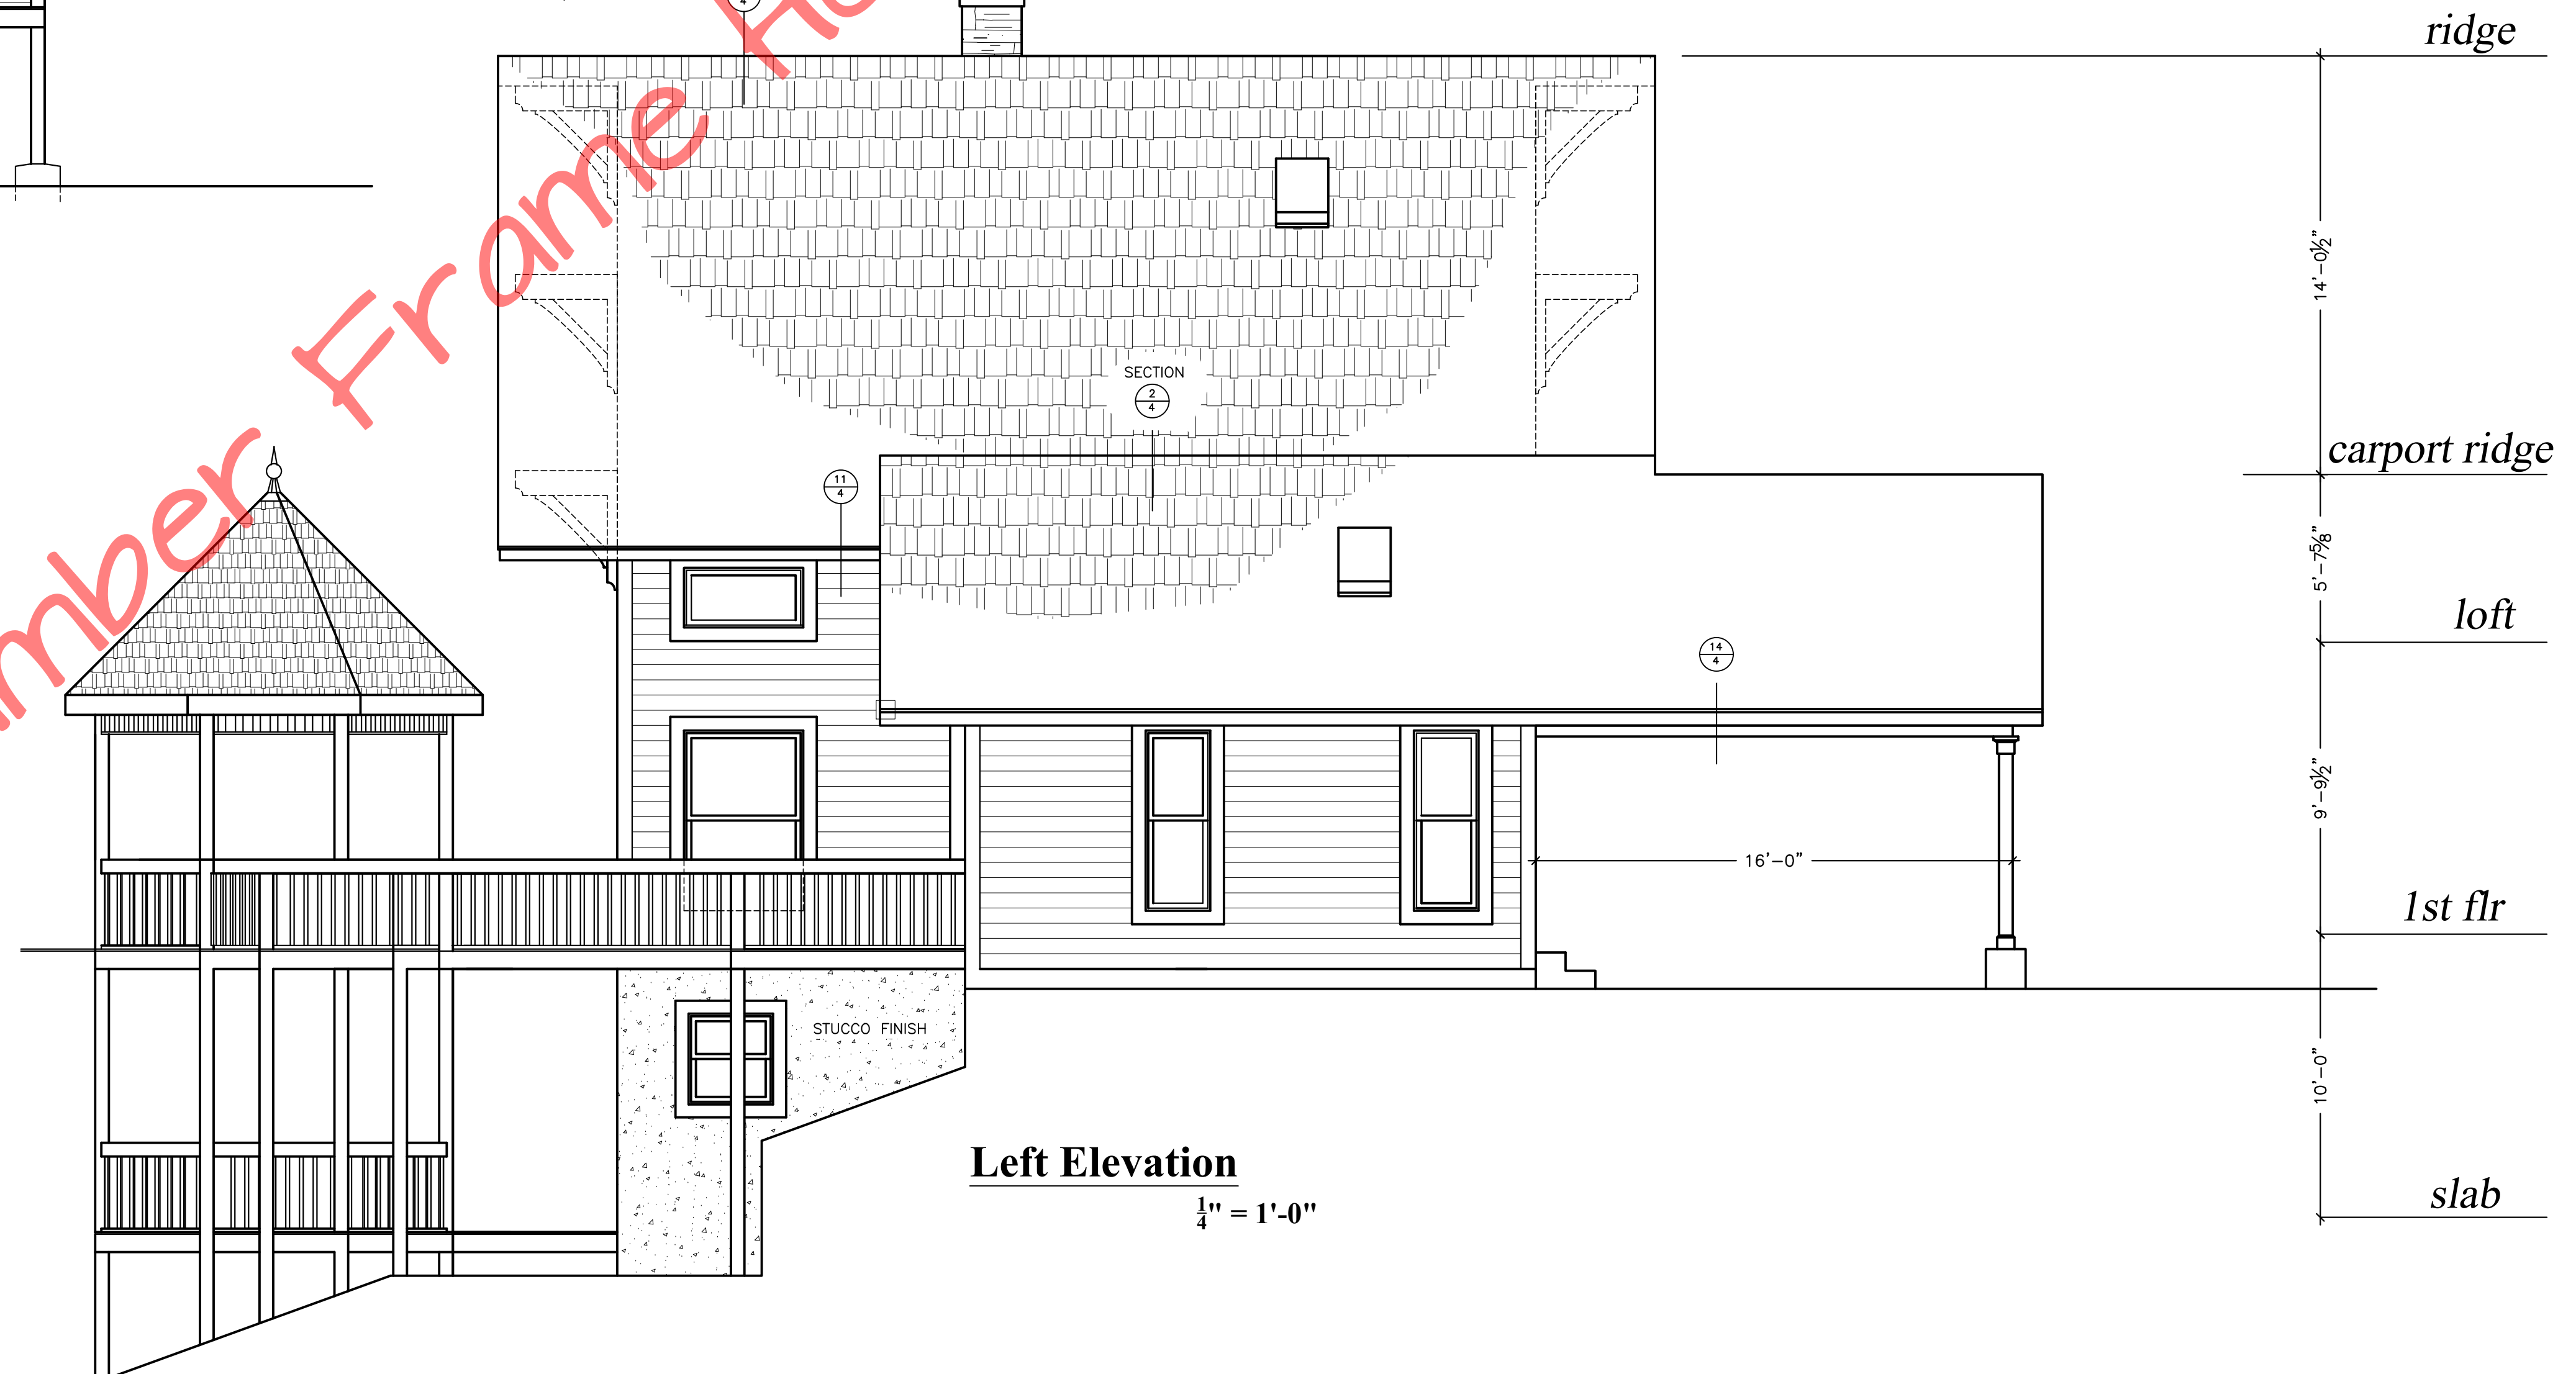
NO.	DATE	REVISIONS	REMARKS	BY



Rear Elevation
 $\frac{1}{4}'' = 1'-0''$




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Left Elevation
 $\frac{1}{4}'' = 1'-0''$

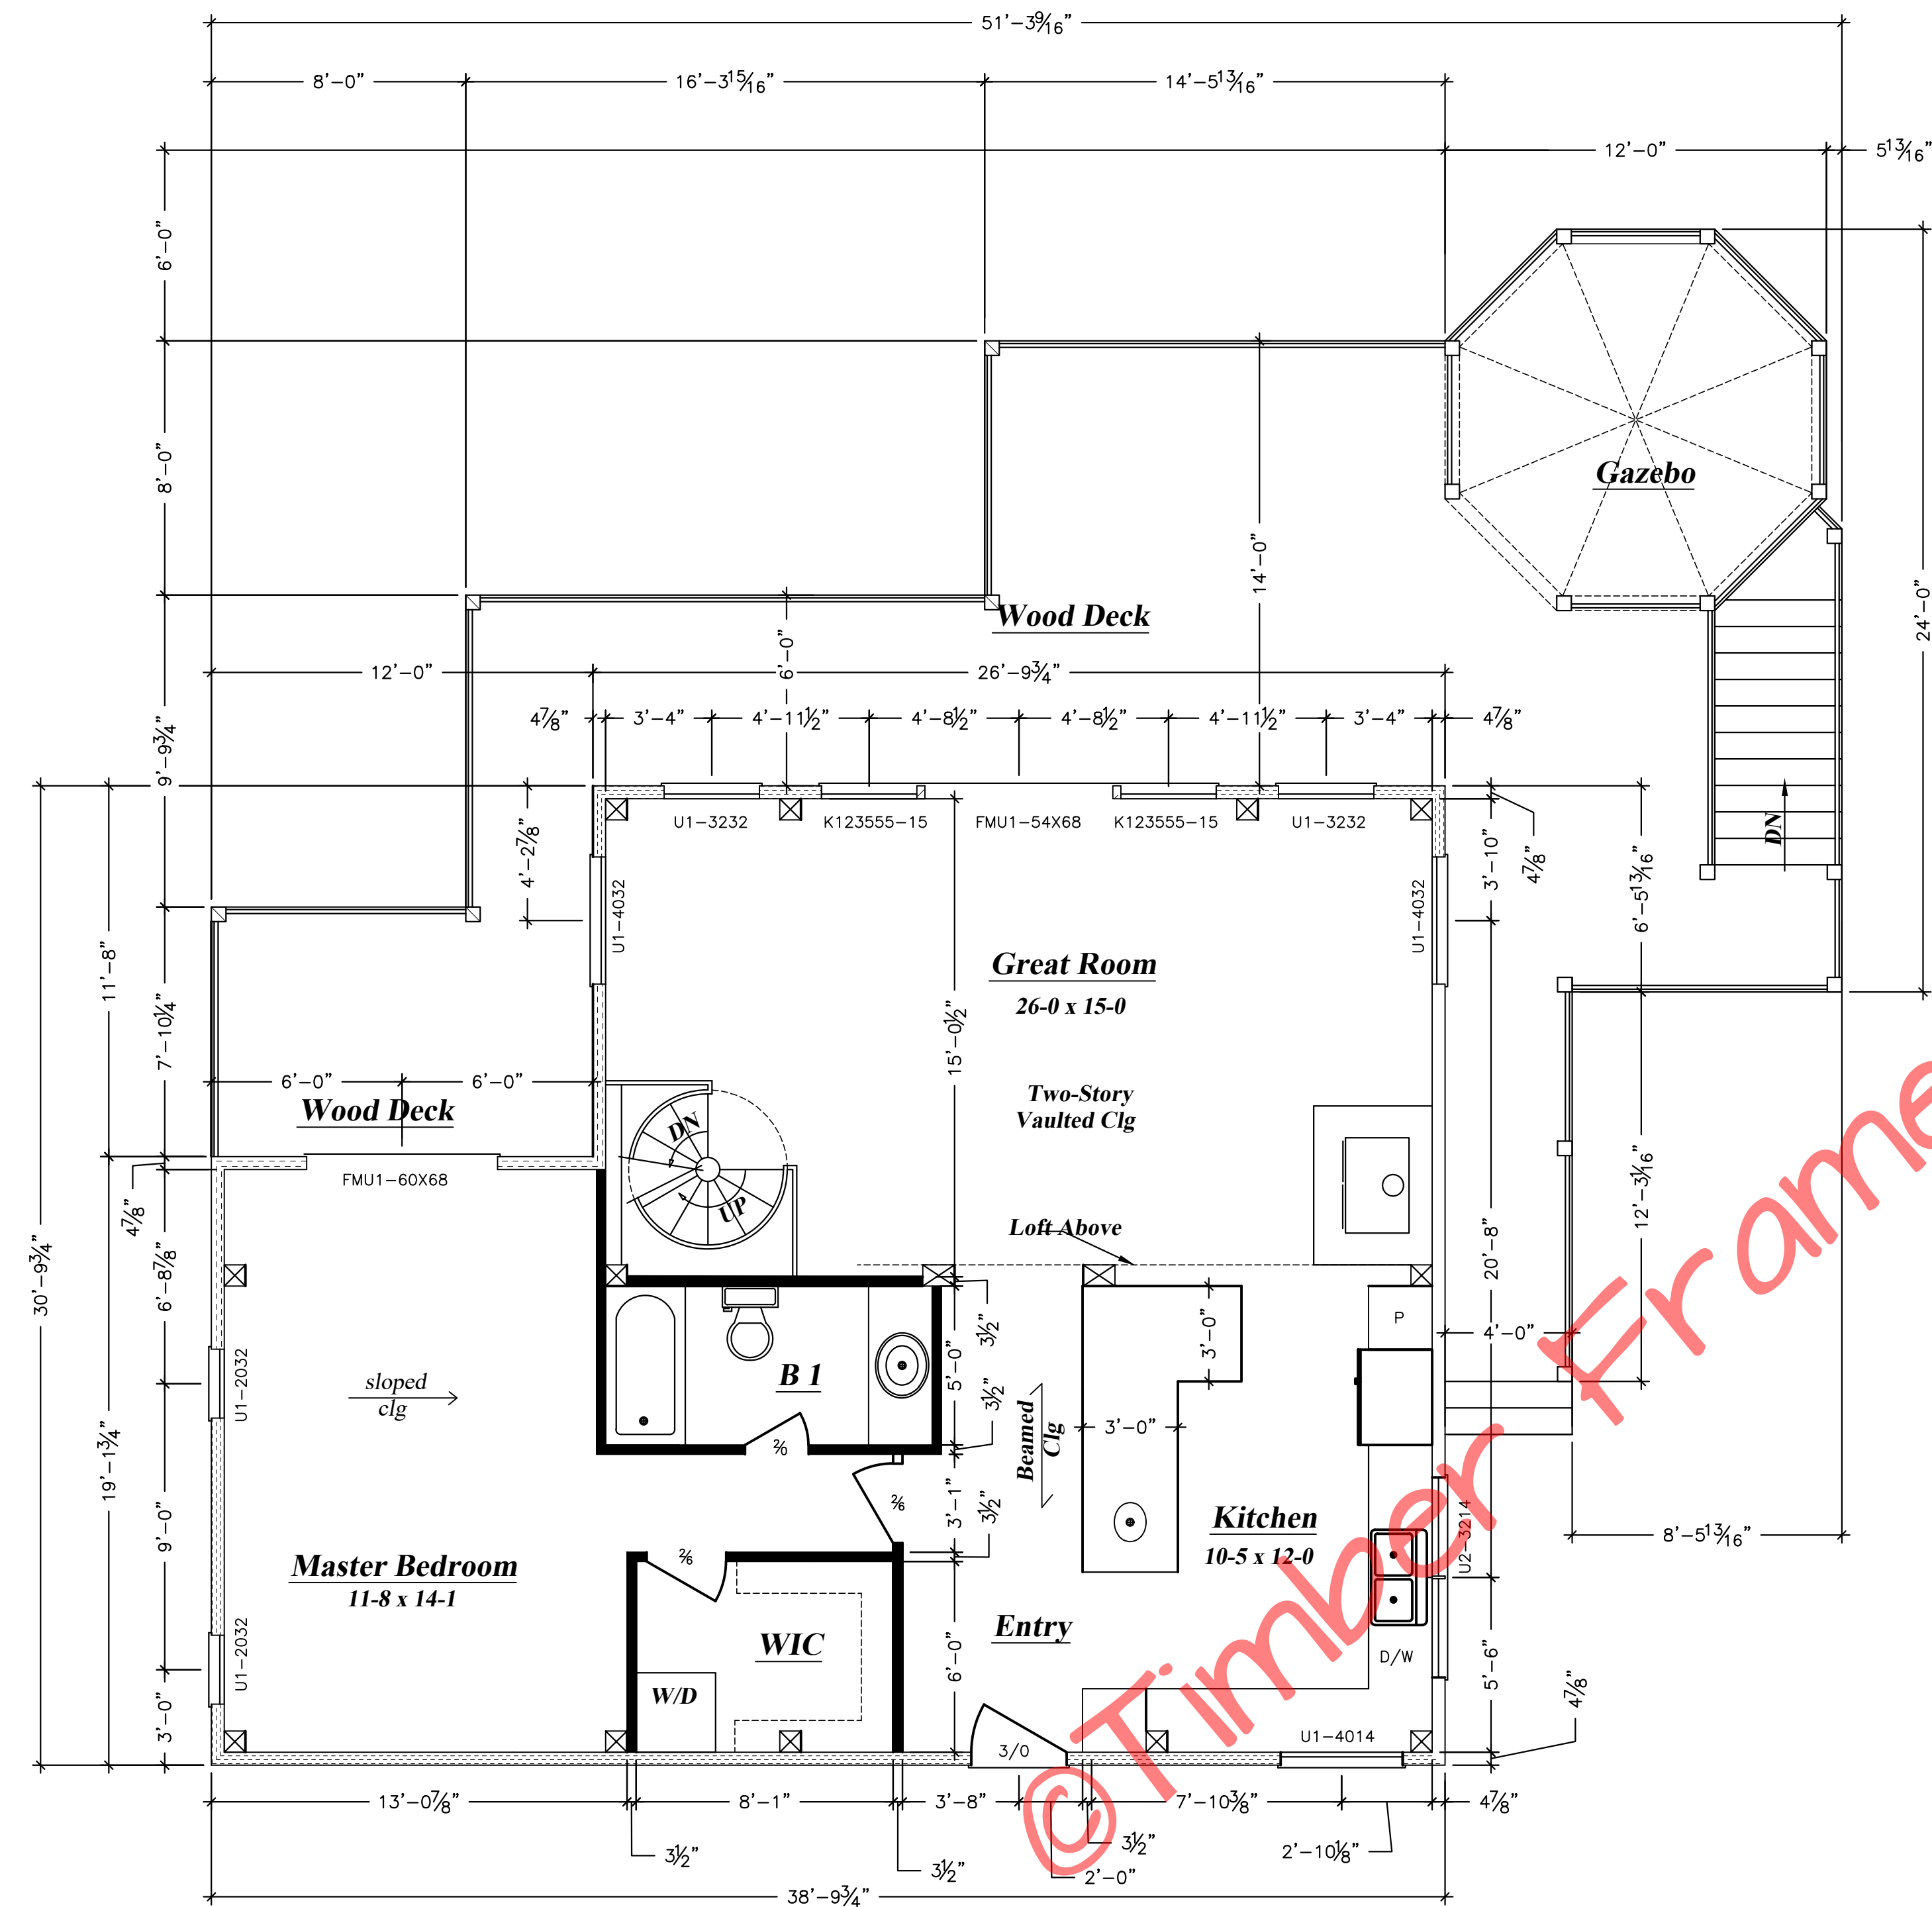
Dover	
REAR & LEFT ELEVATION	
FILE NO.	SHEET NUMBER
NOTED	1A
DATE	04/21/2004
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1A



Carport Not Shown

First Floor Plan
 1,006 sq ft Living Area 1/4" = 1' 0"

NOTES:

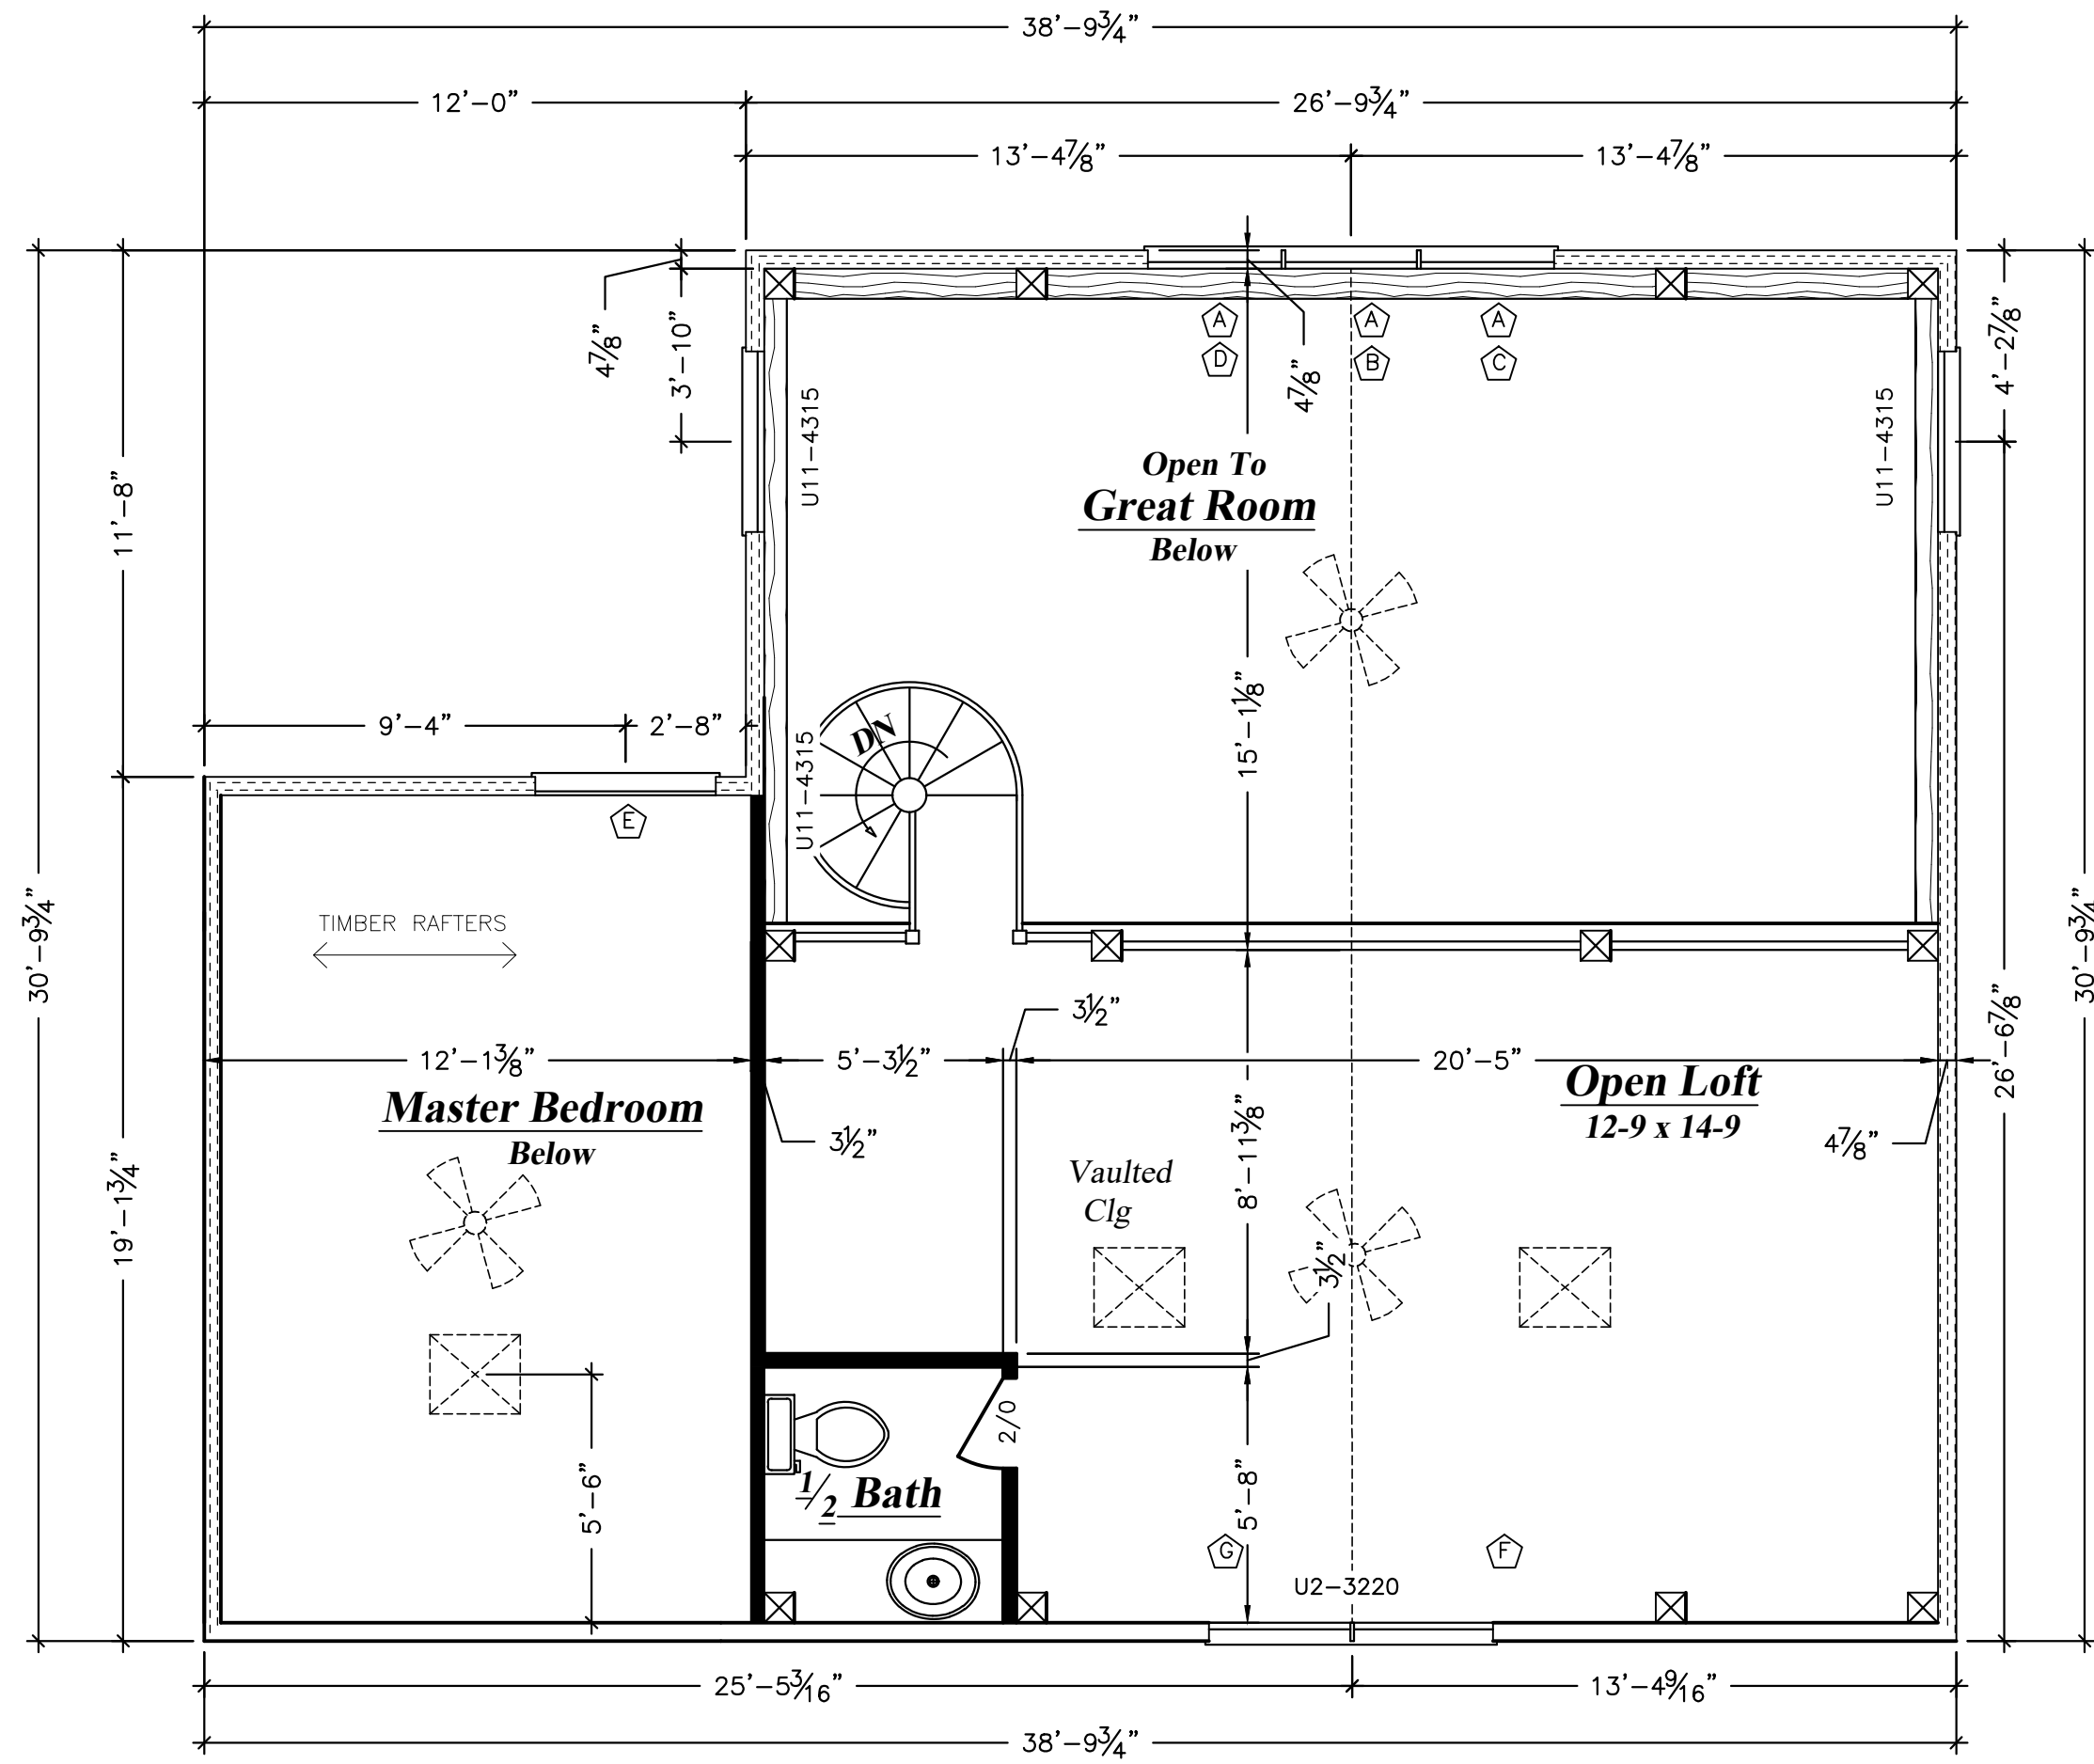
- Timbers are #2 or better Easter White Pine. Unless shown otherwise & are the actual finished dimension unless shown otherwise.
- Timber sizes are based on the following:
 Floor Loading 40 lbs/sf Living/Common areas.
 30 lbs/sf Bedrooms.
 10 lbs/sf Dead
 Roof Loading 20 lbs/sf Snow
 10 lbs/sf Dead
- All post must rest on solid blocking and perimeter must be anchored to resist uplift.
- Loewen window nomenclature
- Exterior walls 4 3/8" Paragon panels (R-26) by Goshen Timber Frames
- Roof deck is 1x6 T&G decking & 6 3/8" Paragon panels (R-40) by Goshen Timber Frames
- Interior walls are 2x4 stud wall construction unless noted by G.C.

Caradco Window & Door Schedule				
LOCATION	QUANTITY	NUMBER	ROUGH OPENING	TYPE
GREAT ROOM 1ST	1	U1-3232	3'-1 3/8" X 6'-0 1/2"	DOUBLE HUNG
GREAT ROOM 1ST	2	U1-4032	3'-10" X 6'-0 1/2"	DOUBLE HUNG
GREAT ROOM 1ST	1	FMU1-54X68	5'-4" X 6'-0 1/2"	FRENCH DOOR
GREAT ROOM 1ST	2	K12 3555-15	3'-4 1/2" X 6'-0 1/2"	AWNING
MASTER BEDRM 1ST	1	FMU1-60X68	6'-0" X 6'-8"	FRENCH DOOR
MASTER BEDRM 1ST	2	U1-2032	2'-2" X 6'-0 1/2"	DOUBLE HUNG
ENTRY 1ST	1	ENTRY	3'-0" X 6'-8"	ENTRY DOOR
KITCHEN 1ST	1	U1-4014	3'-10 1/8" X 3'-0 1/2"	DOUBLE HUNG
KITCHEN 1ST	1	U2-3414	6'-3 1/2" X 3'-0 1/2"	DOUBLE HUNG
GREAT ROOM 2ND	2	U11-4315	4'-0 1/2" X 1'-8 1/2"	AWNING
GREAT ROOM 2ND	3	"A"	3'-4 1/2" X 6'-0 1/2"	FIXED
GREAT ROOM 2ND	1	"B"	3'-4 1/2" X 5'-0 1/2"	FIXED
GREAT ROOM 2ND	1	"C"	"C"	RAKE
GREAT ROOM 2ND	1	"D"	"D"	RAKE
ENTRY 2ND	1	U2-3220	6'-3 1/2" X 4'-0 1/2"	DOUBLE HUNG
ENTRY 2ND	1	"G"	"G"	RAKE
ENTRY 2ND	1	"F"	"F"	RAKE
MASTER BEDRM 2ND	1	"E"	"E"	RAKE
STORAGE BSMT	1	MEU1-30X68	3'-0 1/2" X 6'-8"	DOOR
OFFICE BSMT	1	MEJ30-30X68-30	9'-0 1/2" X 6'-0"	FRENCH DOOR
OFFICE BSMT	1	U1-2814	2'-10" X 3'-0 1/2"	DOUBLE HUNG
STORAGE BSMT	1	U1-2814	2'-10" X 3'-0 1/2"	DOUBLE HUNG
ROOF	2	VELUX EXC101	21 1/2" X 34"	SKYLIGHT
ROOF	1	VELUX EXC104	21 1/2" X 41"	SKYLIGHT

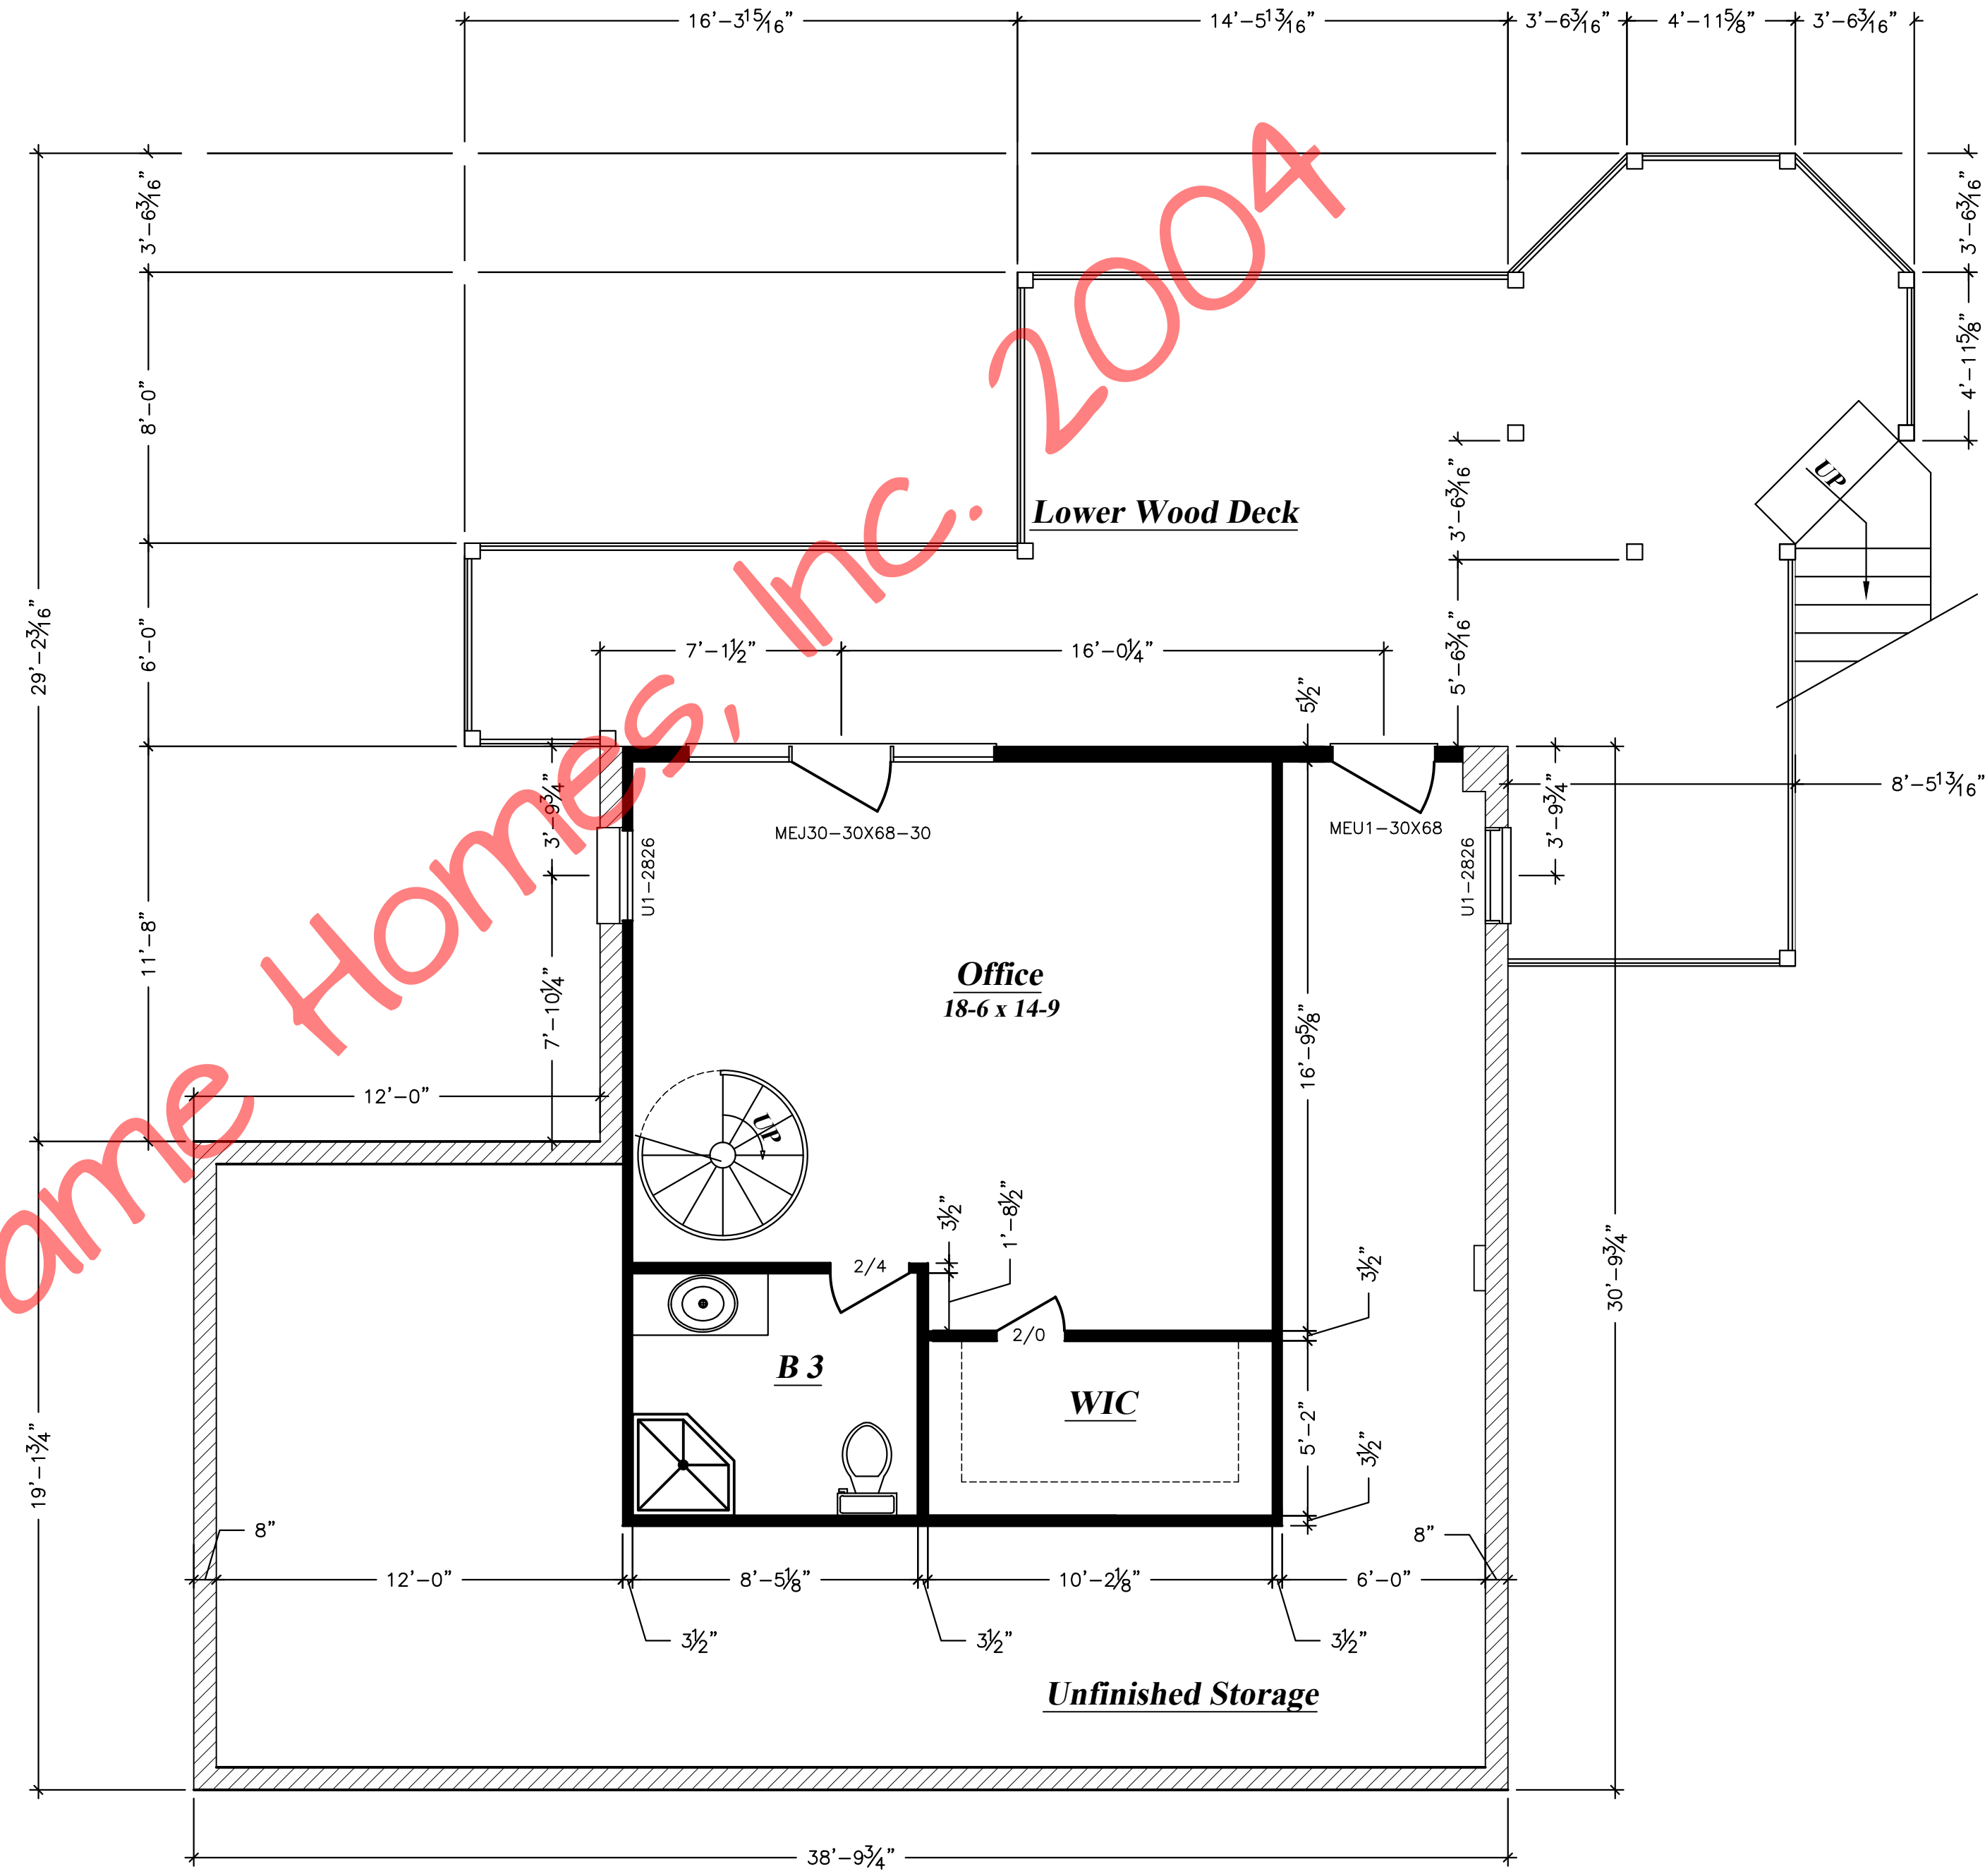


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Second Floor Plan
423 s.f. Living Area 1/8" = 1'-0"



Lower Level Floor Plan
418 s.f. Living Area 1/8" = 1'-0"

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Dover

2ND & LOWER LEVEL PLAN

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DATE: 04/21/2004



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2A